

# Jordan Valley Water Conservancy District

8215 SOUTH 1300 WEST WEST JORDAN, UTAH 84088 PHONE (801) 565-4300

## JORDAN AQUEDUCT, REACH 4 BLOW-OFF DRAIN

4735 NORTH THANKSGIVING WAY, LEHI PROJECT NUMBER: 4232 AUGUST 2025



	REVISIONS				LINE IS 1 INCH ORIGINAL	JA-4 BLOWOFF	DATE
REV.	DESCRIPTION	BY DATE			AT FULL SIZE (IF NOT 1" - SCALE ACCORDINGLY)	37.4 BEOWOTT	8/11/25
				DAN VALLEY WATER	SCALE: NOT TO SCALE	COVER PAGE	
				ISERVANCY DISTRICT	DESIGN: CT	COVERTAGE	PROJECT NUMBER 4232
				8215 SOUTH 1300 WEST ST JORDAN, UTAH 84088-0070	DRAWING: TMP		DRAWING NUMBER
			WE	PHONE (801) 565-4300	PROJ. MGR: CT		SHEET NUMBER _
					APPROVAL:		1 OF 7

#### **GENERAL NOTES:**

- 1. Utilities shown on the drawing are based on the best available information provided by others and should be considered approximate and for general information only. Information is shown for the convenience of the contractor but is not guaranteed to be either correct or complete, and all responsibility for accuracy and completeness thereof is expressly disclaimed. Contractor is responsible to locate and protect all utilities in the project area, including those that may not be shown or that may be shown incorrectly. Contractor is solely responsible for the repair of and utility damaged as a result of the contractor's activities.
- The Contractor shall make such investigations 200' ahead of excavation to locate underground utilities and structures so as not to accidentally damage them during construction operations. The Contractor shall be responsible for repair of any underground utilities damaged during construction activities.
- 3. Contractor shall be responsible for contacting Blue Stakes 48 hours prior to excavating.
- 4. Contractor shall repair or replace all disturbed road striping, and asphalt to appropriate UDOT standards and specifications.
- Contractor shall be responsible for all excavation, road cut, land disturbance, SWPP, and building permits with all agencies/entities impacted by construction (city, state, federal, business, private, etc).
- 6. Contractor shall replace all signal loops disturbed by pipeline installation activities.
- 7. Contractor shall be responsible for flagging, caution signs, traffic control, and public safety on all adjacent streets and construction site per UDOT.
- 8. Contractor shall be responsible for public safety and OSHA safety standards.
- 9. Contractor shall attend all pre construction and construction conferences.
- 10. All construction staking required by the Contractor shall be provided by the Contractor at the Contractor's expense.

- 11. Contractor shall be responsible for care of all construction stakes.
- 12. All materials and construction shall be in accordance with Jordan Valley Water Conservancy District standards and specifications.
- 13. All water lines shall be a minimum of 4 feet below finished grade to top of pipe unless otherwise noted.
- 14. All bends, tees, and other fittings in water line to be supported with concrete thrust blocks and restrained with Mega-Lug followers at joints, unless otherwise noted.
- 15. Contractor shall be responsible for all erosion control.
- 16.Contractor shall employ BMP around all storm drains.
- 17. Contractor shall legally dispose of all excess excavated material/debris off site unless otherwise noted.
- 18. Contractor shall supply redlines for preparation of record drawings.
- 19. Contractor shall be responsible to contact Salt Lake County Surveyor's office prior to disturbing any survey monument. Replace monuments at contractors expense.
- 20. Surface improvements disturbed during this work shall be replaced as part of the work. All associated costs shall be included in the contractors bid.
- 21. Contractor shall legally dispose of all excess excavated material off site.
- 22. Contractor must obtain Encroachment Permit from UDOT, Region 3.

#### ABBREVIATIONS:

**BMP** Best Management Practices

CTV Cable Television

DIA Diameter

FL Flanged

MJ Mechanical Joint

NTS Not to Scale

OSHA Occupational Safety & Health Administration

P Power Line

PVC Polyvinyl Chloride

SS Stainless Steel

TYP Typical

**UDOT Utah Department of Transportation** 

W Water Line

Know what's below.
Call before you dig.

	REVISIONS	REVISIONS  DESCRIPTION BY DATE	
REV.	DESCRIPTION	BY	DATE



LINE	IS 1 INCH	7	ORIGINAL
AT F F NOT 1" - SCA	7)   Y)	B	
		.,	
CALE: NO	T TO SCALE		
ESIGN:	СТ		
RAWING:	TMP		
ROJ. MGR:	СТ		
PPROVAL:	<u>-</u>		ĺ

JA-4 BLOWOFF

NOTES

PROJECT NUMBER

4232

DRAWING NUMBER


G-2


SHEET NUMBER


2 OF 7


7

:\AQUEDUCT\JA-4\4232 - JA4 BLOWOFFS\ENGINEERING\DRAWING\951\_649\JA4 BLOWOFFS UTILITIES 2.DWG

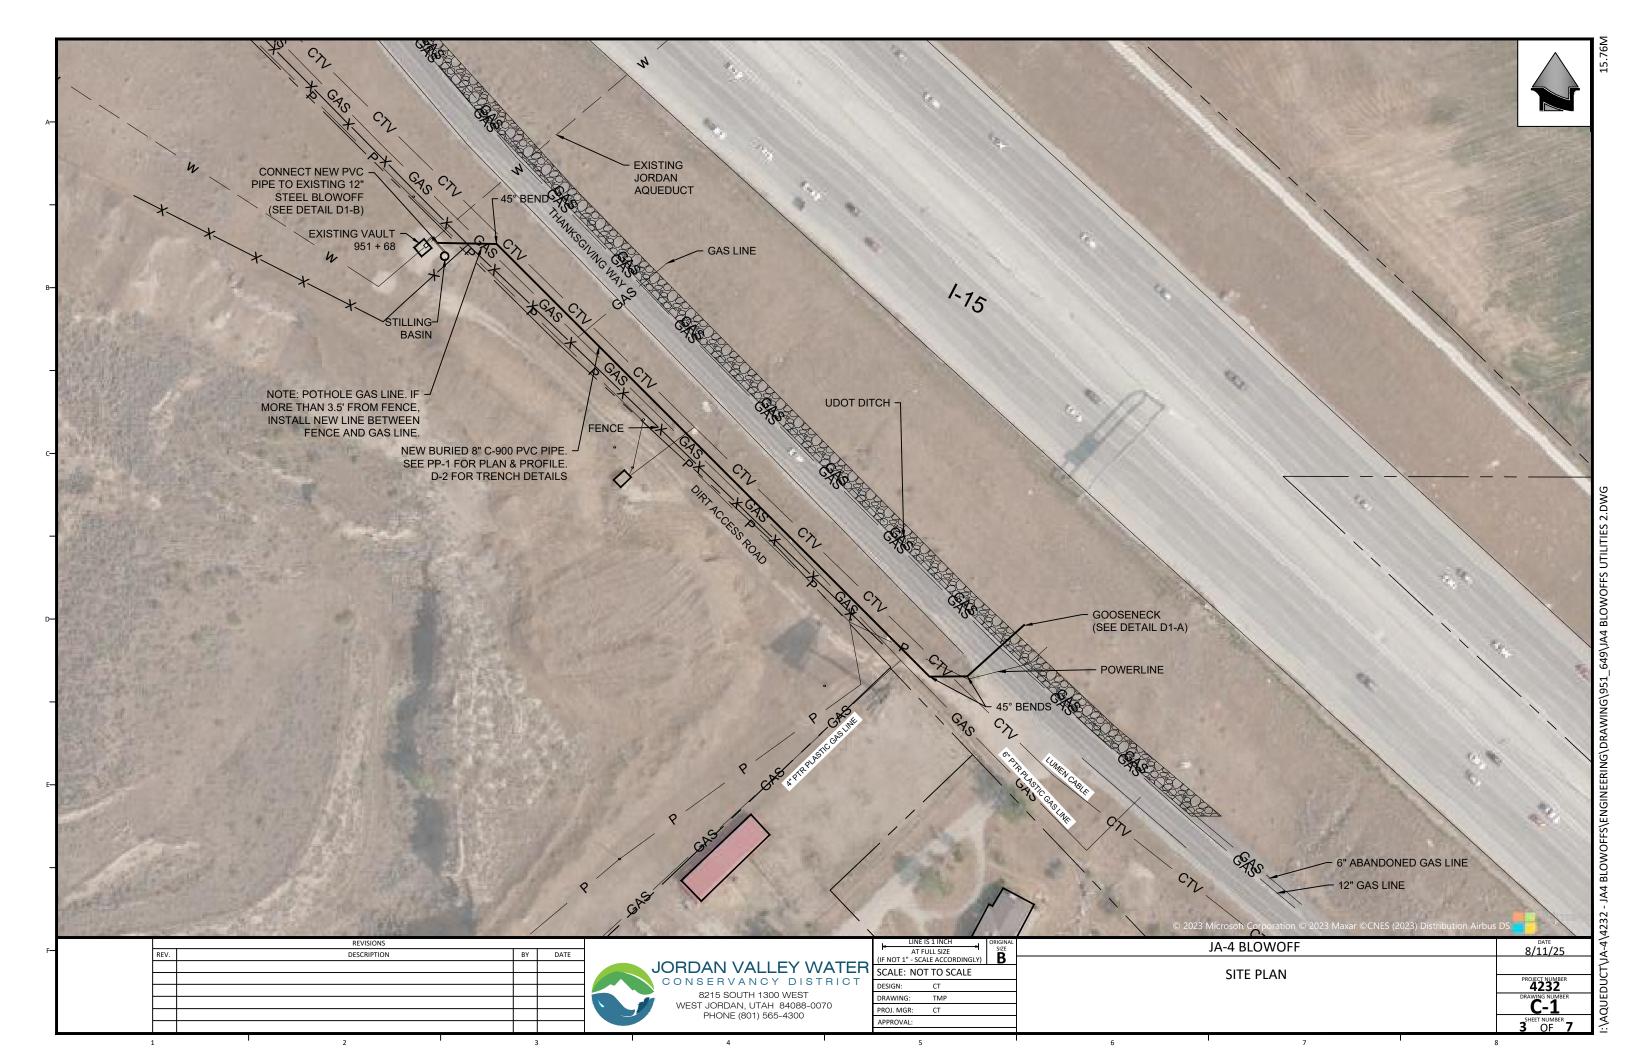


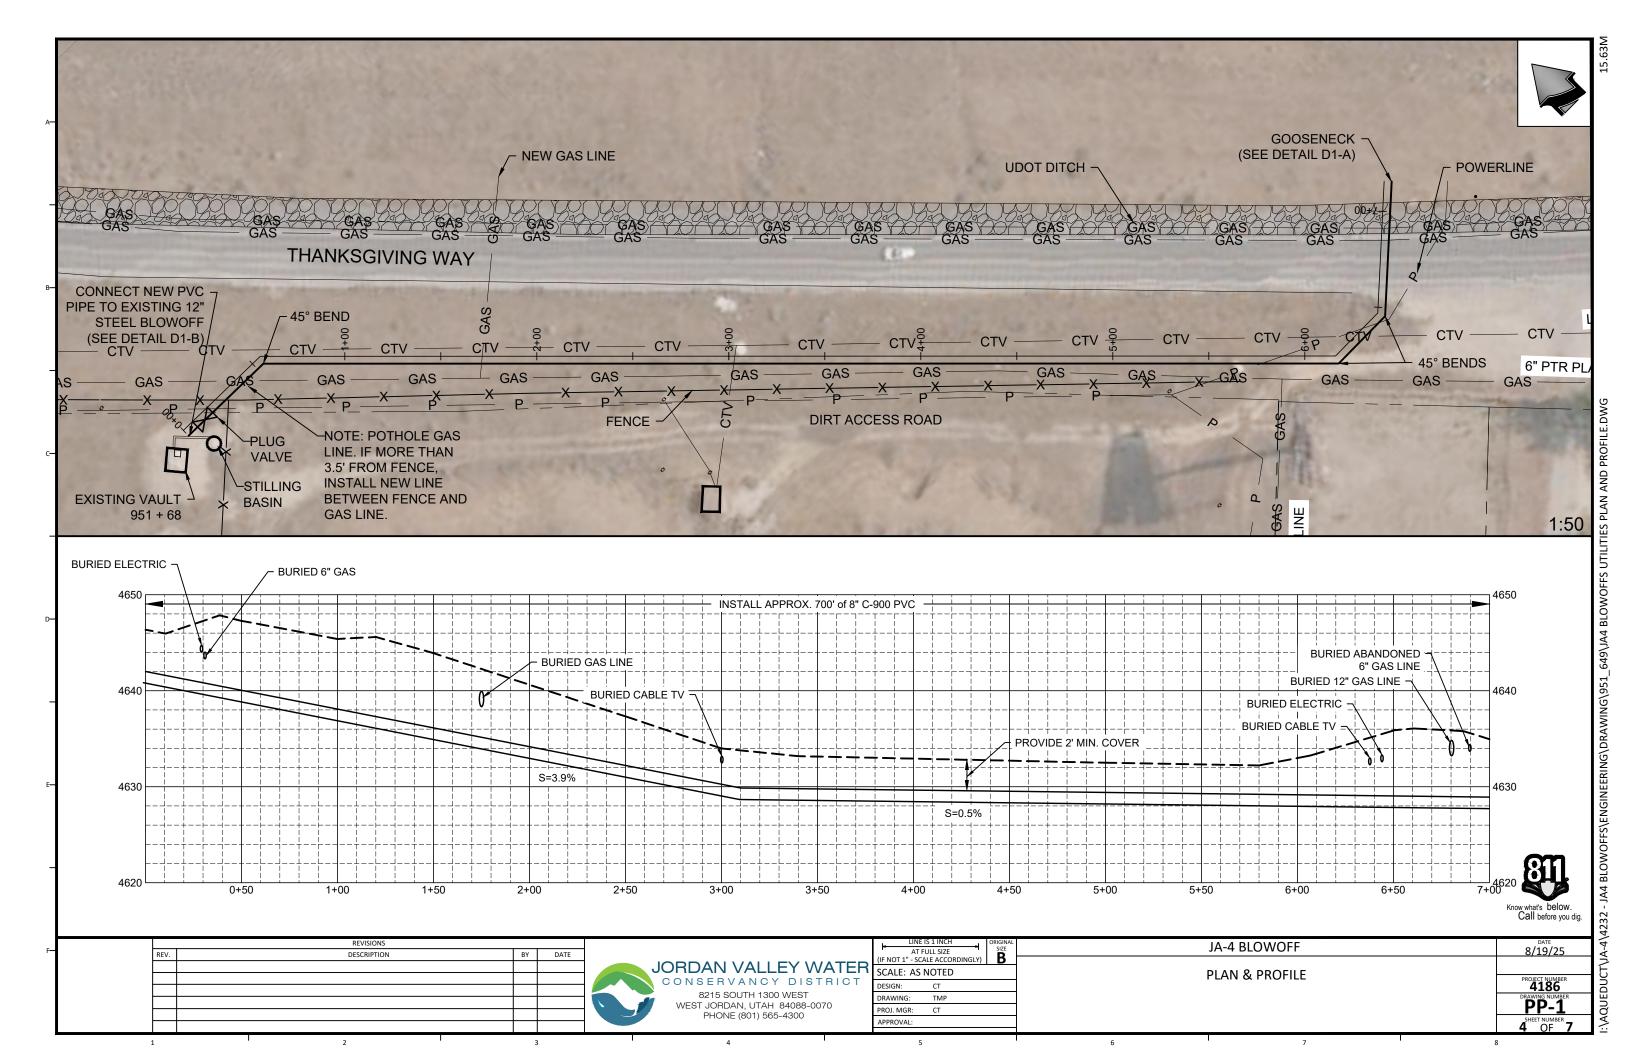


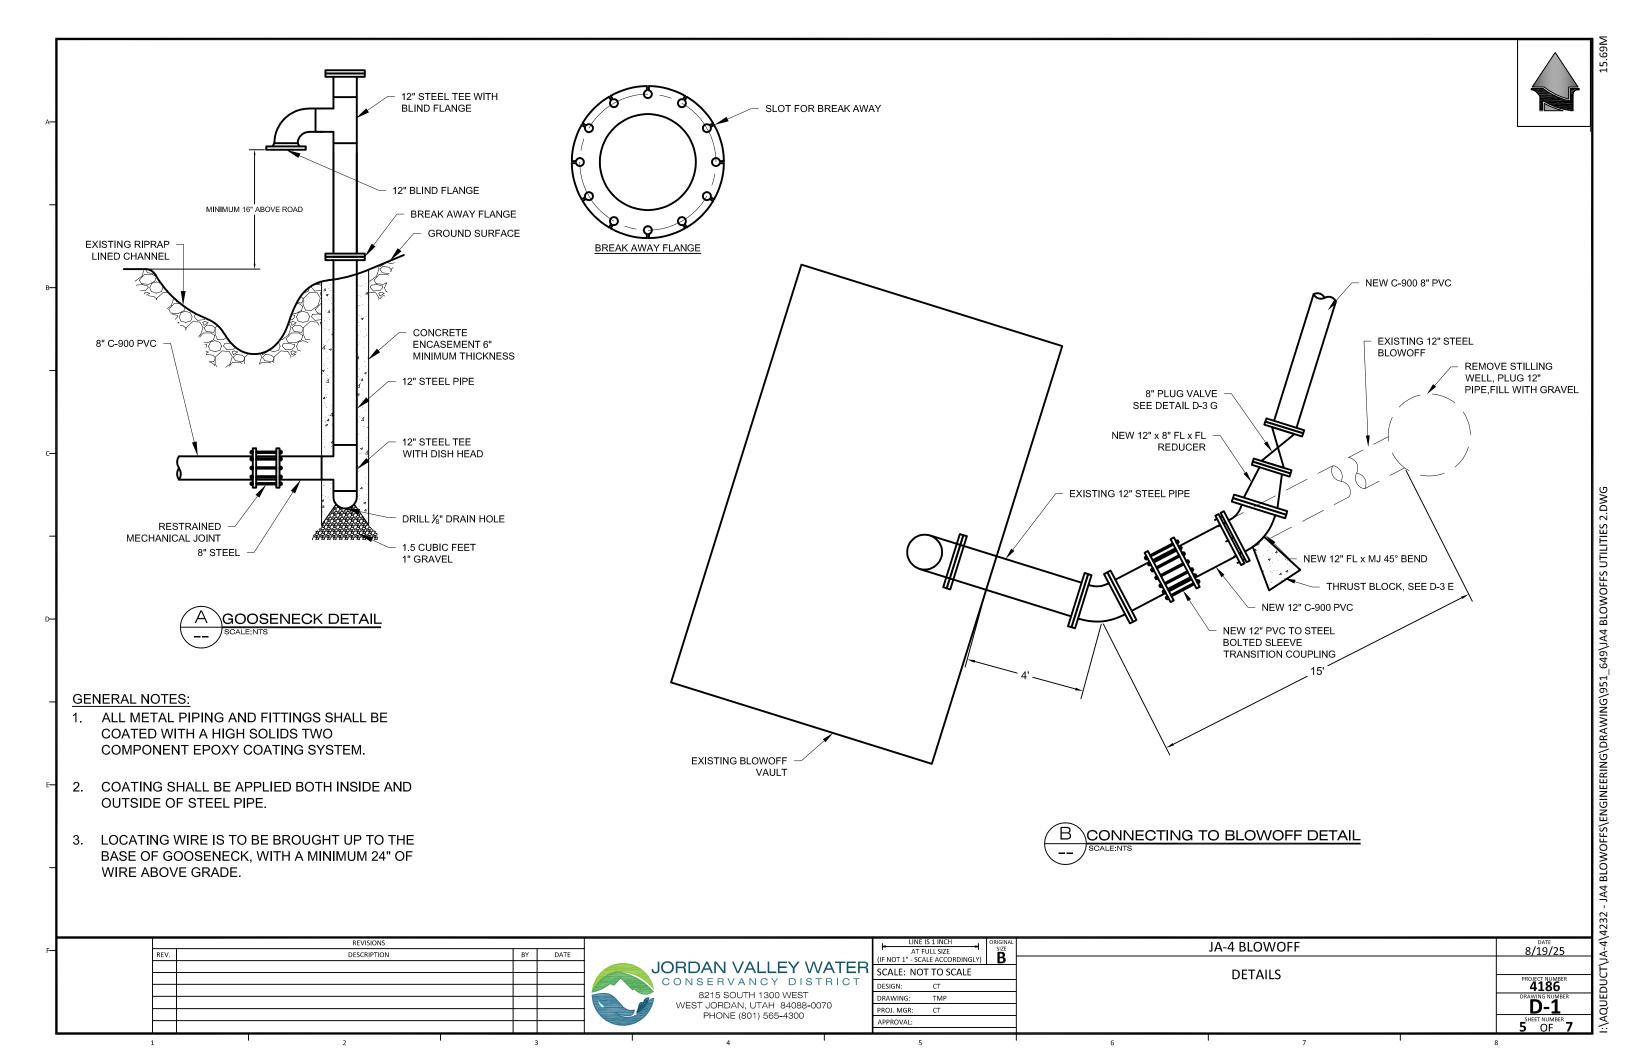

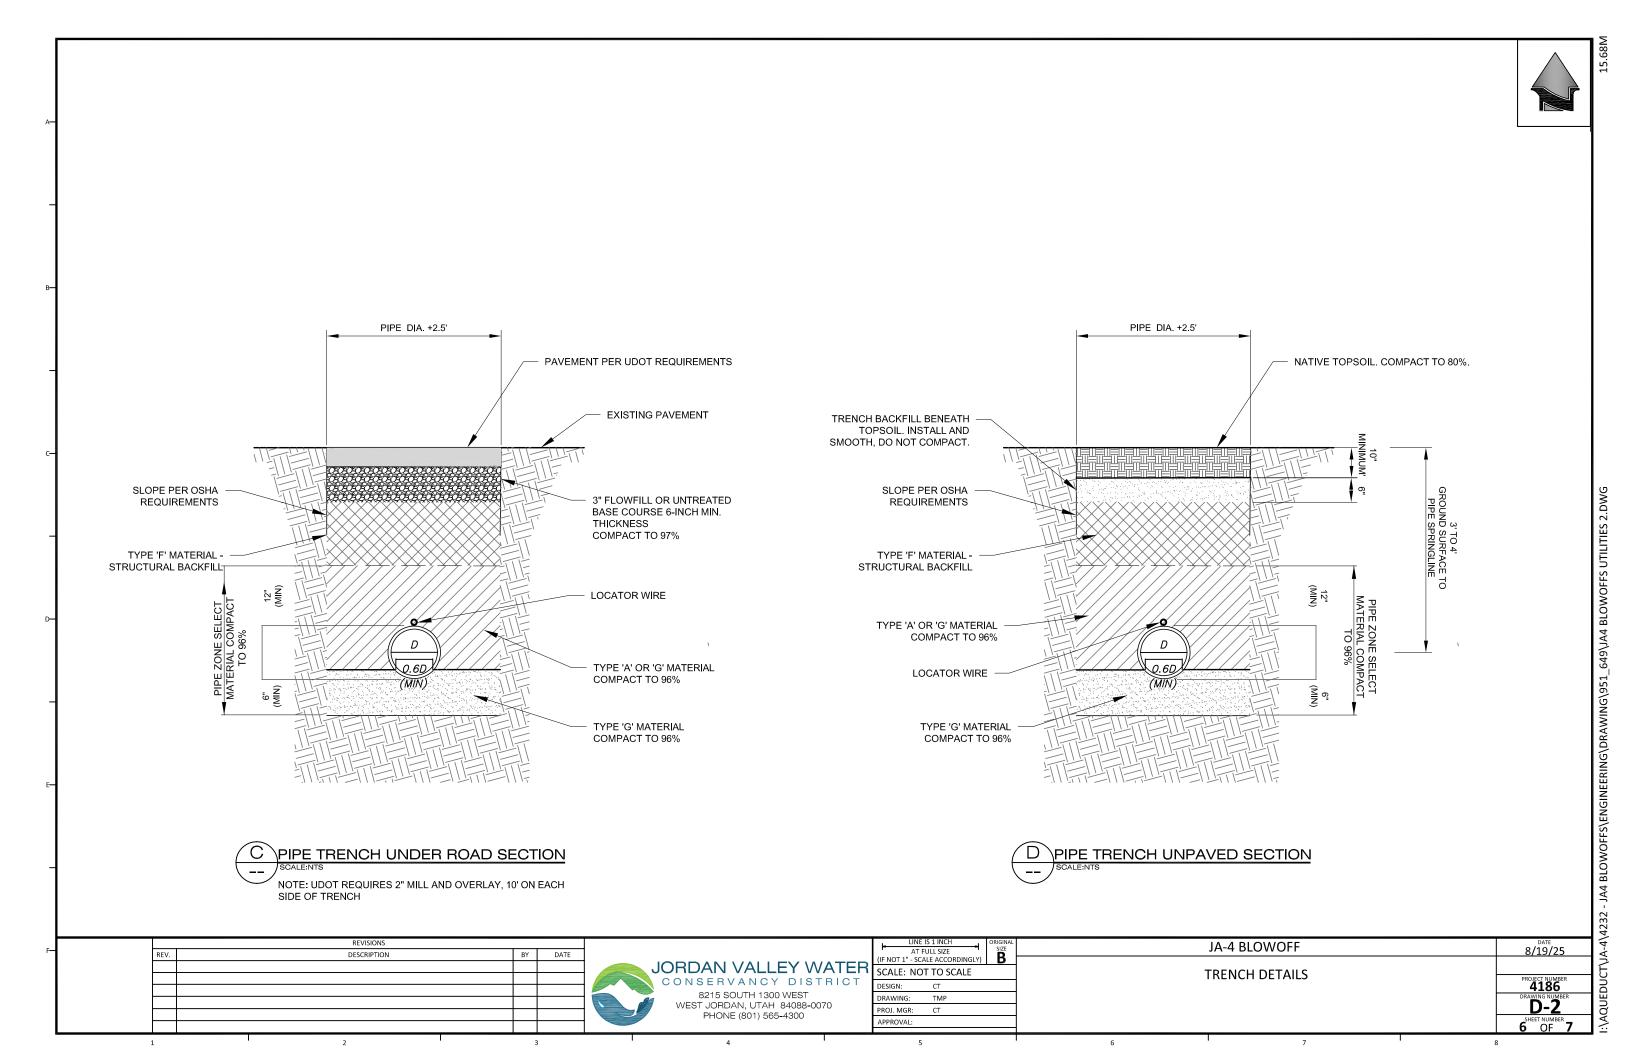



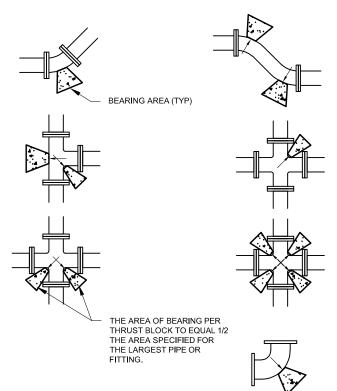

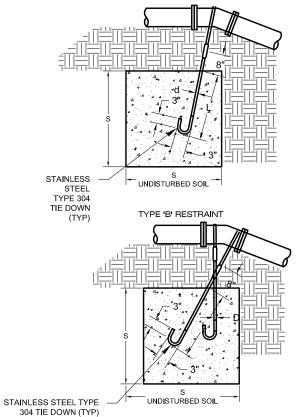

TYPE 'A' RESTRAINT

NOTES:

- 1. CONCRETE SHALL BE 4,000 PSI.
- 2. MIN YIELD STRENGTH OF STEEL TIE-DOWN BARS
- 3. POUR CONCRETE AGAINST UNDISTURBED SOILS.
- APPLY GREASE TO ALL BURIED METAL

MI	NIMUM	BEARIN	IG ARE	IN SQ. F	-T.	
0124 01 11 4	TEES, VALVES DEAD ENDS	90° BENDS	45° BENDS	22 1/2" BENDS	11 1/4" BENDS	<u>-</u>
	2	3	2	2	2	
"	4	5.5	3	1.5	1	
"	6.5	9.5	5	2.75	1.5	
2"	14	20	11	5.5	3	
ļ"	19	26.5	14.5	7.5	4	
6"	24	34	18.5	9.5	6	_

27

53

81

52

74

114

28.5

41

62

14.5

21

32

16

53

16

SIZE

4"

6"

8"

12"


14"


16"

20"

24"

30"

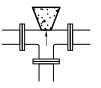

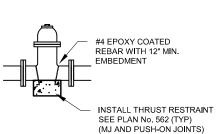


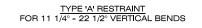


	TABLE OF DIMENSIONS				
	VB		S	d	L
PPE SIZE NOMIN. DIAMTER-INCH	VERTICAL BEND DEGREES	NO. OF CU FT. OF CONC. BLOCKING	SIDE OF CUBE FEET	DIAMETER OF SHACK OR REBAR RODS-INCH	DEPTH OF RODS IN CONCRETE FT.
4"	11.25°	8	20	5/8"	1.5
4	22.5°	15.6	2.5	5/8"	2.0
6"	11.25°	15.6	2.5	5/8"	2.0
"	22.5°	34.3	3.25	5/8"	2.0
8"	11.25°	27	3.0	5/8"	2.0
L°	22.5°	64	4.0	5/8"	2.0
10"	11.25°	45.5	3.5	3/4"	2.0
_ 10	22.5°	94.5	4.5	3/4"	3.0
12"	11.25°	64	4.0	3/4"	2.0
	22.5°	125	5.0	3/4"	3.0
14"	11.25°	86	4.4	3/4"	2.0
L'*	22.5°	171	5.6	3/4"	3.0
16"	11.25°	107	4.25	7/8"	3.0
Li	22.5°	216	6.0	7/8"	4.0

### TYPE 'B' RESTRAINT FOR 45° VERTICAL BENDS

	TABLE	OF D	IMEN	SIONS	3
	VB		S	d	L
PPE SIZE NOMIN. DIAMTER -INCH	VERTICAL BEND DEGREES	NO. OF CU FT. OF CONC. BLOCKING	SIDE OF CUBE FEET	DIAMETER OF SHACK OR REBAR RODS-INCH	DEPTH OF RODS IN CONCRETE FT.
4"	45°	1	3.0	5/8"	2.0
				5/8"	
6"	45°	2.37	4.0	5/8"	2.5
۰	45	2.57	4.0	5/8"	2.5
011	450	0.07	4.75	5/8"	
8"	45°	3.97	4.75	5/8"	2.0
				5/8"	
10"	45°	6.51	5.50	5/8"	3.0
	4=0			5/8"	
12"	45°	9.04	6.25	5/8"	4.0
	4=0			5/8"	
14"	45°	12.70	7.00	5/8"	4.0
40"	450	47.04		3/4"	4.0
16"	45°	17.24	7.75	3/4"	4.0



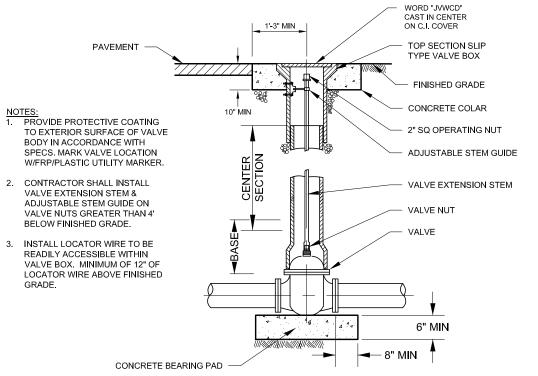

TYPICAL VERTICAL THRUST BLOCK



_		REVISIONS			Γ
F-	REV.	DESCRIPTION	BY	DATE	



1	LINE IS	ORIGINAL SIZE						
	(IF NOT 1" - SCALE ACCORDINGLY)							
	SCALE: NOT TO SCALE							
ı	DESIGN:	СТ						
ı	DRAWING:	TMP						
ı	PROJ. MGR:	CT						
1	A DDD COVAL							

JA-4 BLOWOFF 8/11/25 **GENERAL DETAILS** PROJECT NUMBER 4186

**D-3** 7 OF 7 I:\AQUEDUCT\JA-4\4232 - JA4 BLOWOFFS\ENGINEERING\DRAWING\951\_649\JA4 BLOWOFFS UTILITIES 2.DWG